


ASRY BASIN
(500M WIDE)

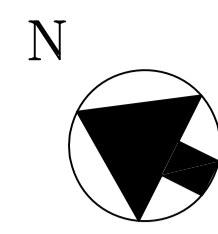


FUTURE QUAY WALL

SLIPWAYS NO.1 & NO.2 (UNDER CONSTRUCTION)	
DRY LENGTH PER SLIPWAY	255.00 M
MAXIMUM VESSEL LIGHT WEIGHT	5,000 MT
--- -- LENGTH	140.00 M
--- -- BREADTH	20.00 M
--- -- DRAUGHT @ ZERO TIDE	2.76 M
--- -- DRAUGHT @ NORMAL TIDE	4.56 M
--- -- DRAUGHT @ SPECIAL TIDE	5.56 M

FLOATING DOCK NO. 2	
L.O.A.	252.00 M
L.O. KEEL BLOCKS	235.00 M
O.A. WIDTH	53.00 M
CLEAR WIDTH BETWEEN W.W.	44.00 M
MAX. DEPTH ABOVE KEEL BLOCKS	9.70 M
D.D. LIFTING CAP.	33,000 MT.

FLOATING DOCK NO. 3	
L.O.A.	227.00 M
L.O. KEEL BLOCKS	210.00 M
O.A. WIDTH	49.00 M
CLEAR WIDTH BETWEEN W.W.	40.00 M
MAX. DEPTH ABOVE KEEL BLOCKS	9.70 M
D.D. LIFTING CAP.	30,000 MT.

GRAVING DOCK NO. 1	
LENGTH	375.00 M
BREADTH	75.00 M
SILL DEPTH	9.00 M
MAX. DRAUGHT @ ZERO TIDE	8.50 M
MAX. DRAUGHT @ NORMAL TIDE	10.30 M
MAX. DRAUGHT @ SPECIAL TIDE	11.50 M
HEIGHT OF KEEL BLOCKS	1.80 M
CAPACITY	500,000 DWT

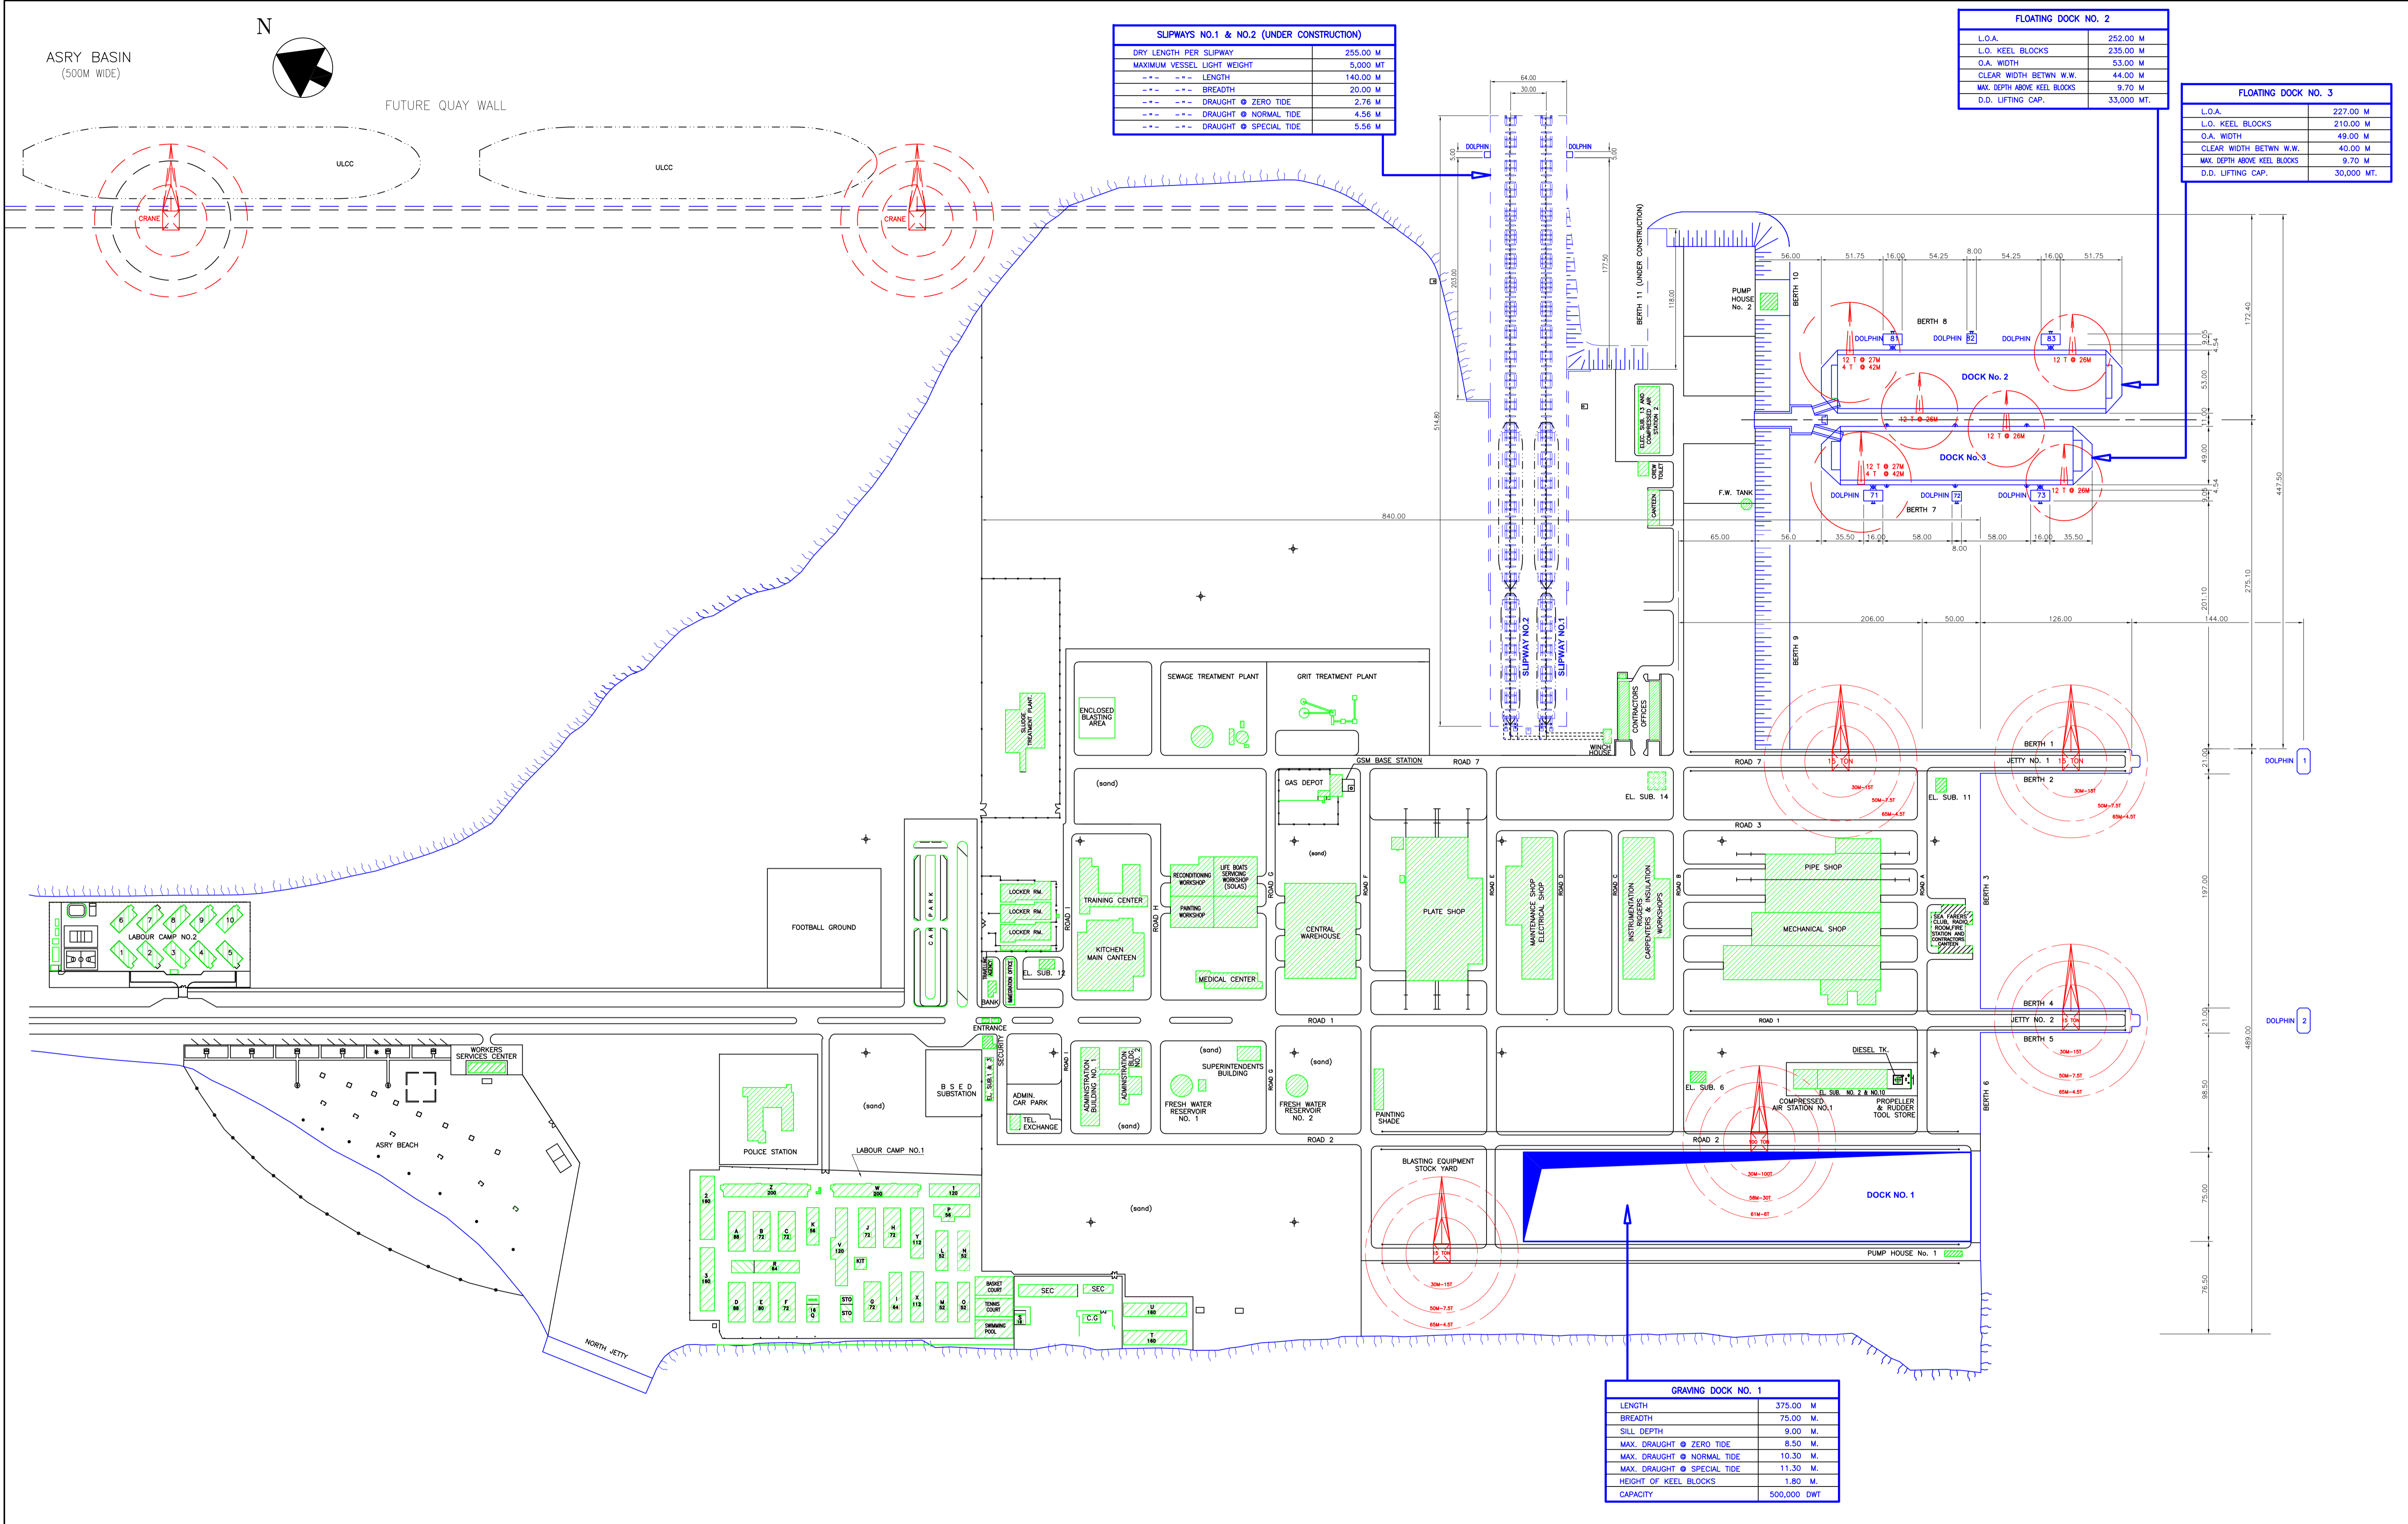

ASRY SITE PLAN

SCALE 1:2500

ASRY SITE PLAN - WEB

	ARAB SHIPBUILDING & REPAIR YARD	DRAWN BY: SSG	SCALE: 1 : 2500	DATE: 07-11-2007
		CHECKED BY: AEB	DWG. NO.:	1158
		APPROVED BY: AEB		